



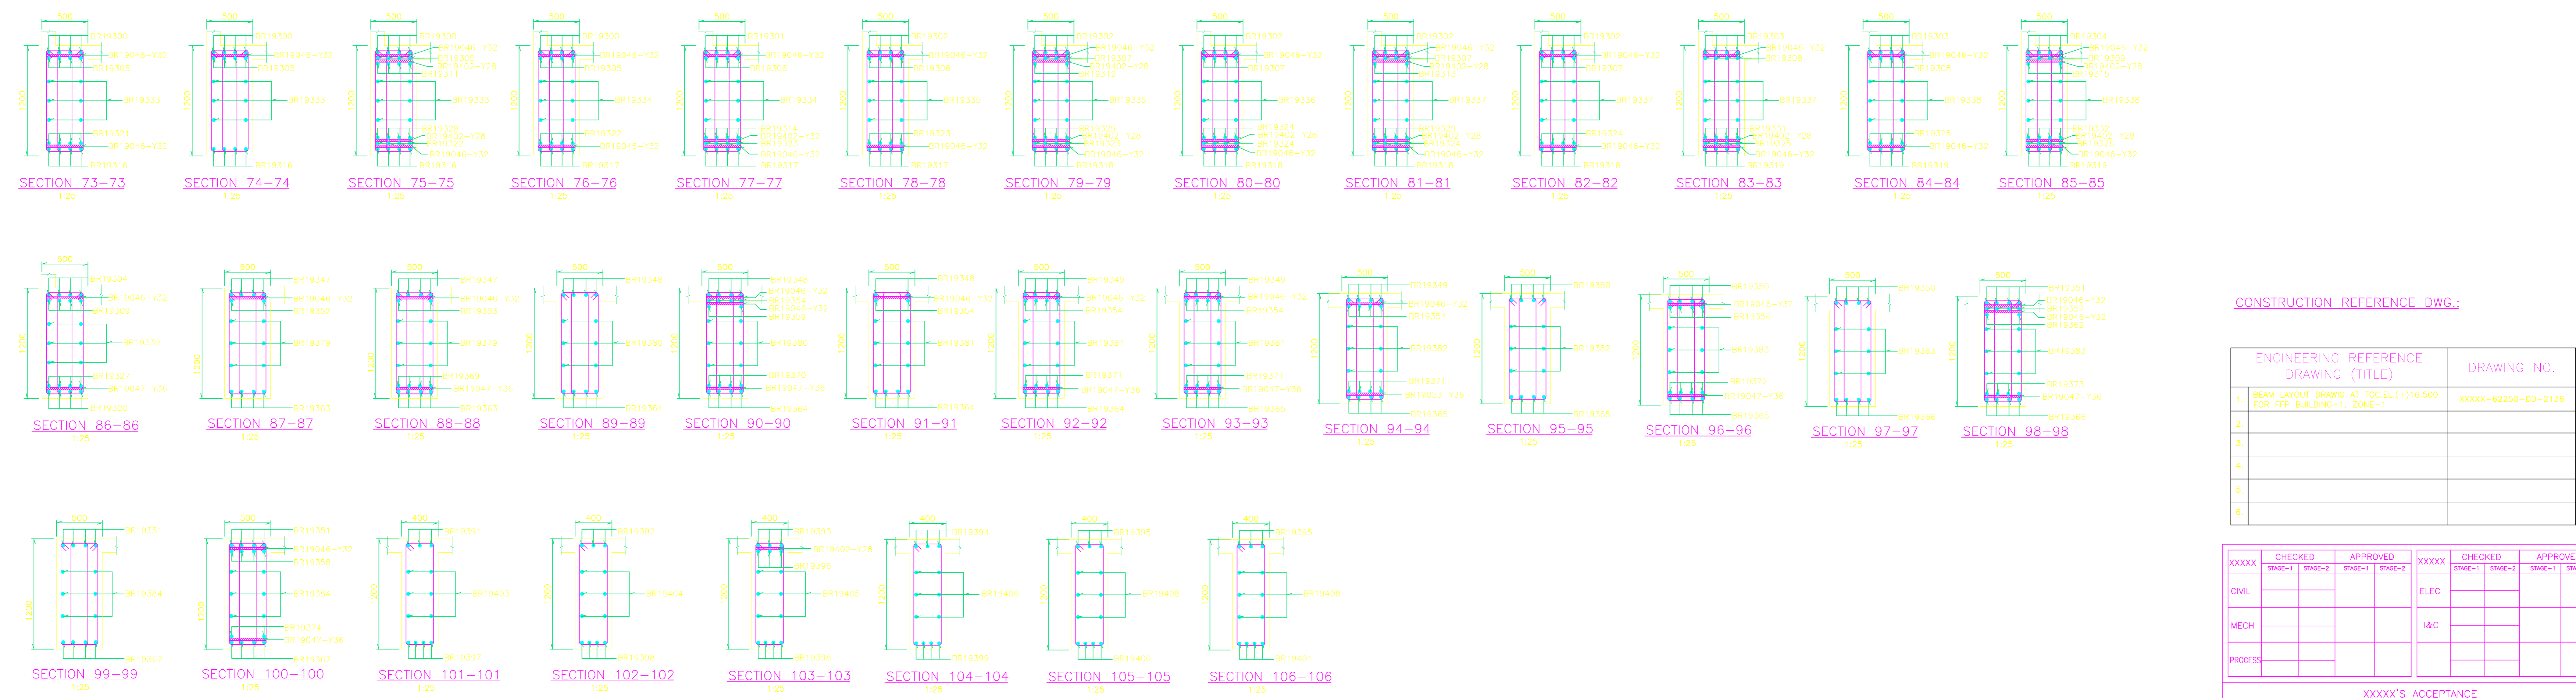

- LEGENDS:**
- TYP — TYPICAL
  - UNO — UNLESS NOTED OTHERWISE
  - EL — ELEVATION LEVEL
  - CL — CENTER LINE
  - ANC. — ANCHOR LENGTH
  - THK — THICKNESS
  - TOC — TOP OF CONCRETE
  - CL — CENTER LINE
  - CJ — CONSTRUCTION JOINT
  - COUPLER

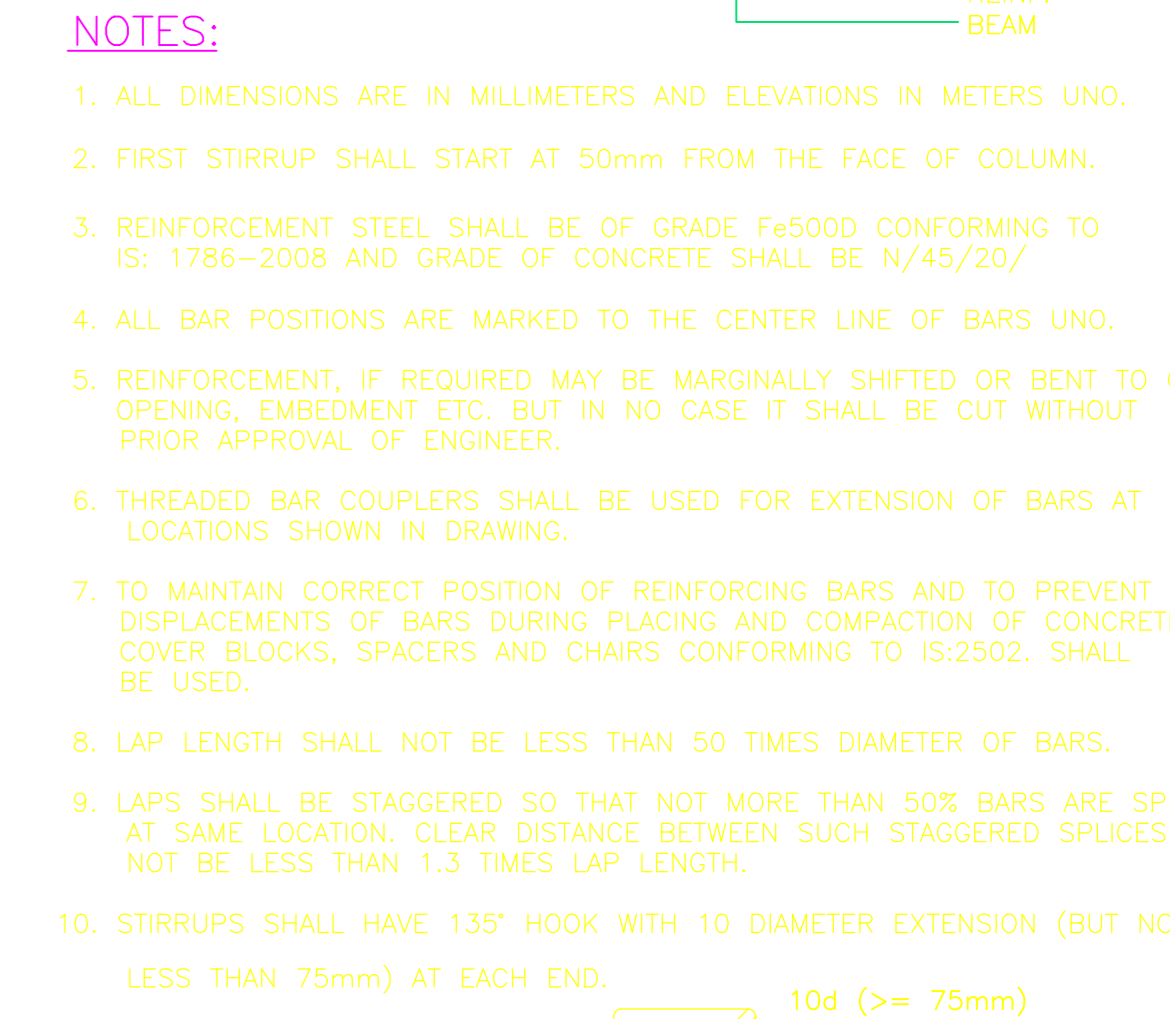

CONSTRUCTION REFERENCE DWG.:

ENGINEERING REFERENCE DRAWING (TITLE)				DRAWING NO.		REV NO.	
1.	BEAM LAYOUT DRAWING AT TOCEL(+16.500 FOR FFP BUILDING-1, ZONE-1)	XXXXX-62250-DD-2136					C
2.							
3.							
4.							
5.							
6.							

XXXXX	CHECKED		APPROVED		XXXXX	CHECKED		APPROVED	
	STAGE-1	STAGE-2	STAGE-1	STAGE-2		STAGE-1	STAGE-2	STAGE-1	STAGE-2
CIVIL					ELEC				
MECH					I&C				
PROCESS									

XXXXX'S ACCEPTANCE

DO NOT SCALE

CLIENT : \_\_\_\_\_

PROJECT : \_\_\_\_\_

TITLE: REINFORCEMENT DETAILS OF BEAMS

ORIGINATING AGENCY: \_\_\_\_\_

DRG. NO.: FRFCF/XXXXX/XX/XXXX

DESIGNER: \_\_\_\_\_ DATE: \_\_\_\_\_

DRAWN: \_\_\_\_\_ DATE: \_\_\_\_\_

CHECKED: \_\_\_\_\_ DATE: \_\_\_\_\_

APPROVED: \_\_\_\_\_ DATE: \_\_\_\_\_

SCALE: 1:100

PROJECTION:

REV: \_\_\_\_\_

X

ISSUE No.	DESCRIPTION	DATE	REV. NO.	DRAWN BY	DESIGNER	DESIGNED BY	PROCESS	CIVIL	ELEC.	MECH/SP. PKG.	I&C	APPROVED
1	REVIEW AND COMMENTS	15.07.11	A	ERK	ASD							
2	REVISED AS MARKED	21.07.11	B									
3	REVISED AS MARKED	25.07.11	C									
	DRAWING RELEASED FOR											
	ISSUE BLOCK											

THIS DESIGN AND DRAWING IS THE PROPERTY OF IT SHALL NOT BE USED, REPRODUCED OR COMMUNICATED WITHOUT THE PERMISSION OF THE OWNER.